
CONTRACTOR SHALL REQUEST A CONSTRUCTION SET PRIOR TO BEGINNING ANY WORK ON THIS PROJECT.

DESIGN BASED ON SURVEY PROVIDED BY D.R. FREDERICK & ASSOCIATES. DATED JULY 22, 2016. CONTRACTOR SHALL VERIFY THAT THESE PLANS ARE THE MOST CURRENT AVAILABLE PRIOR TO BEGINNING CONSTRUCTION, AND SHALL NOTIFY THE ENGINEER/OWNER IMMEDIATELY IF THEY ARE NOT.

PROPOSED FUEL CENTER EXPANSION KROGER J956

JOHNSON COUNTY PARCEL: 41-08-10-044-002.000-009

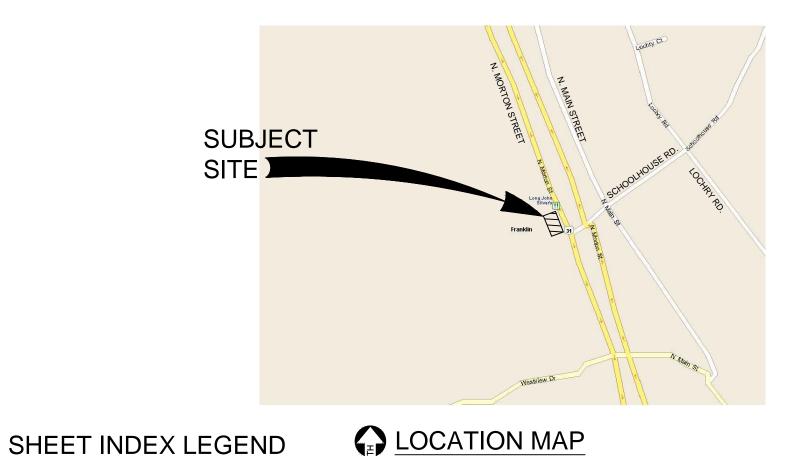

NO SCALE

SURVEY (BY D.R. FREDERICK & ASSOCIATES)

00-00-00

MOST RECENT REVISION DATE

FILLED CIRCLE INDICATES DRAWING INCLUDED WITH THIS ISSUE

GENERAL (BY SSOE)

CIVIL (BY SSOE)

08-05-2016 CD1......EXISTING CONDITIONS & REMOVAL PLAN

• 07-22-2016 EXPANDED TOPOGRAPHIC SURVEY (FOR REFERENCE ONLY)

LATEST REVISION NUMBER

ISSUE/REVISION SHEET SHEET

● 08-05-2016 G0.1.....COVER SHEET

DATE NO. NAME

08-05-2016 C1.1.....SITE PLAN

08-05-2016 C1.4.....SWPPP

08-05-2016 C1.3......UTILITY PLAN

08-05-2016 C5.1......SITE SPECIFIC DETAILS

GENERAL NOTES (APPLICABLE TO ALL SHEETS):

- 1. WORK SHALL CONFORM TO THE REQUIREMENTS OF GOVERNING AGENCIES HAVING JURISDICTION. GRADING, PAVING, AND MATERIALS SHALL COMPLY WITH THE STATE DEPARTMENT OF TRANSPORTATION STANDARD SPECIFICATIONS FOR CONSTRUCTION AS WELL AS PROJECT SPECIFICATIONS AND DRAWINGS. IN CASE OF DISCREPANCIES BETWEEN REQUIREMENTS, THE MOST STRINGENT SHALL APPLY.
- 2. DIMENSIONS SHOWN ON THESE DRAWINGS ARE TO BACK OF CURB, OUTSIDE FACE OF BUILDING FOUNDATIONS, EDGE OF PAVEMENT OR CENTER OF STRUCTURE OR SIGN UNLESS NOTED OTHERWISE.
- 3. NO DIMENSION MAY BE SCALED. REFER UNCLEAR ITEMS TO THE ENGINEER FOR INTERPRETATION.
- 4. ELECTRONIC CADD FILES ARE AVAILABLE UPON REQUEST FOR THE PURPOSE OF LAYOUT. SSOE GROUP CLAIMS NO RESPONSIBILITY WHATSOEVER FOR THE ELECTRONIC CADD FILES OR FOR INCORRECT INTERPRETATIONS ONCE TURNED OVER TO THE CONTRACTOR.
- 5. CONTRACTOR SHALL OBTAIN ALL NECESSARY CONSTRUCTION PERMITS AND LICENSES REQUIRED TO PERFORM ALL REQUIRED WORK. CONTRACTOR SHALL POST ALL BONDS, PAY ALL FEES (EXCEPT AS SPECIFIED IN THE PROJECT MANUAL), PROVIDE PROOF OF INSURANCE AND PROVIDE TRAFFIC CONTROL NECESSARY FOR THIS WORK.

BENCHMARK DATA:


LOCAL BENCHMARK (NOT SHOWN) PAINTED CIRCLE WITH PK NAIL ON LEFT UPSTREAM HEADWALL EAST OF US #31 ON BRIDGE OVER CANARY DITCH SET BY IDNR ELEVATION = 753.07 (NGVD 1929)

SITE BENCHMARK #1 (NOT SHOWN) PK NAIL FOUND ELEVATION = 750.95 (NGVD 1929)

SITE BENCHMARK #2 FINISHED FLOOR ELEVATION QUIZNO'S RESTAURANT ELEVATION = 751.49 (NGVD 1929)

(ADD 0.80 TO ALL ELEVATIONS OBTAIN NAVD 1988)

NORTH MORTON STREET (US ROUTE 31)

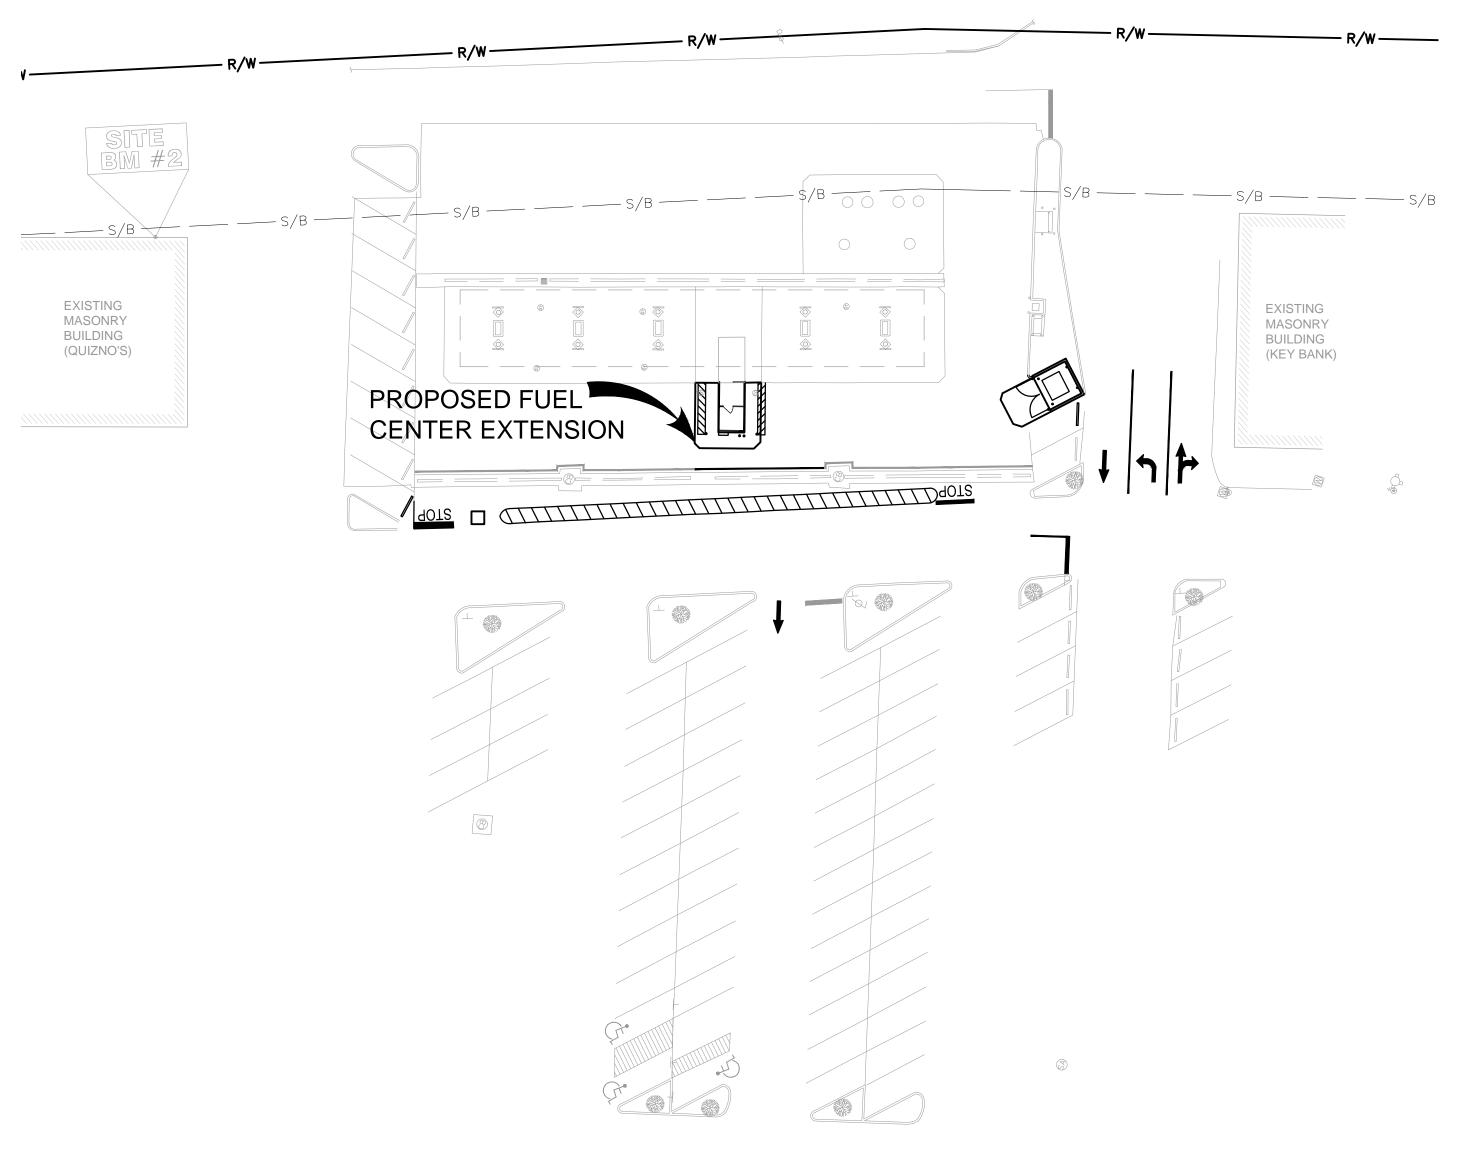

RIGHT-OF-WAY LINE CONCRETE ASPHALT-HEAVY DUTY ASPHALT-LIGHT DUTY CLEAN OUT

STANDARD LEGEND DESCRIPTION PROPOSED **EXISTING** WATER SANITARY PROPERTY LINE SETBACK LINE

CIVIL ENGINEER

INDIANAPOLIS, IN 46250

PH: (317) 579-8008


OWNER/DEVELOPER

5960 CASTLEWAY WEST DRIVE

CONTACT: REGGIE HENDERSON

THE KROGER LIMITED PARTNERSHIP I

1050 WILSHIRE DR., SUITE 260 TROY, MI 48084-1526 CONTACT: MICHELLE ALFIERI PH: (669) 800-5946

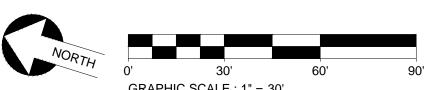




Know what's below.

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Project No.: 016-00622-00	S +	DESCRIPTION SITE PLAN APPROVAL
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HARTMAN ddress: 1700 NORTHWOOD PLAZA


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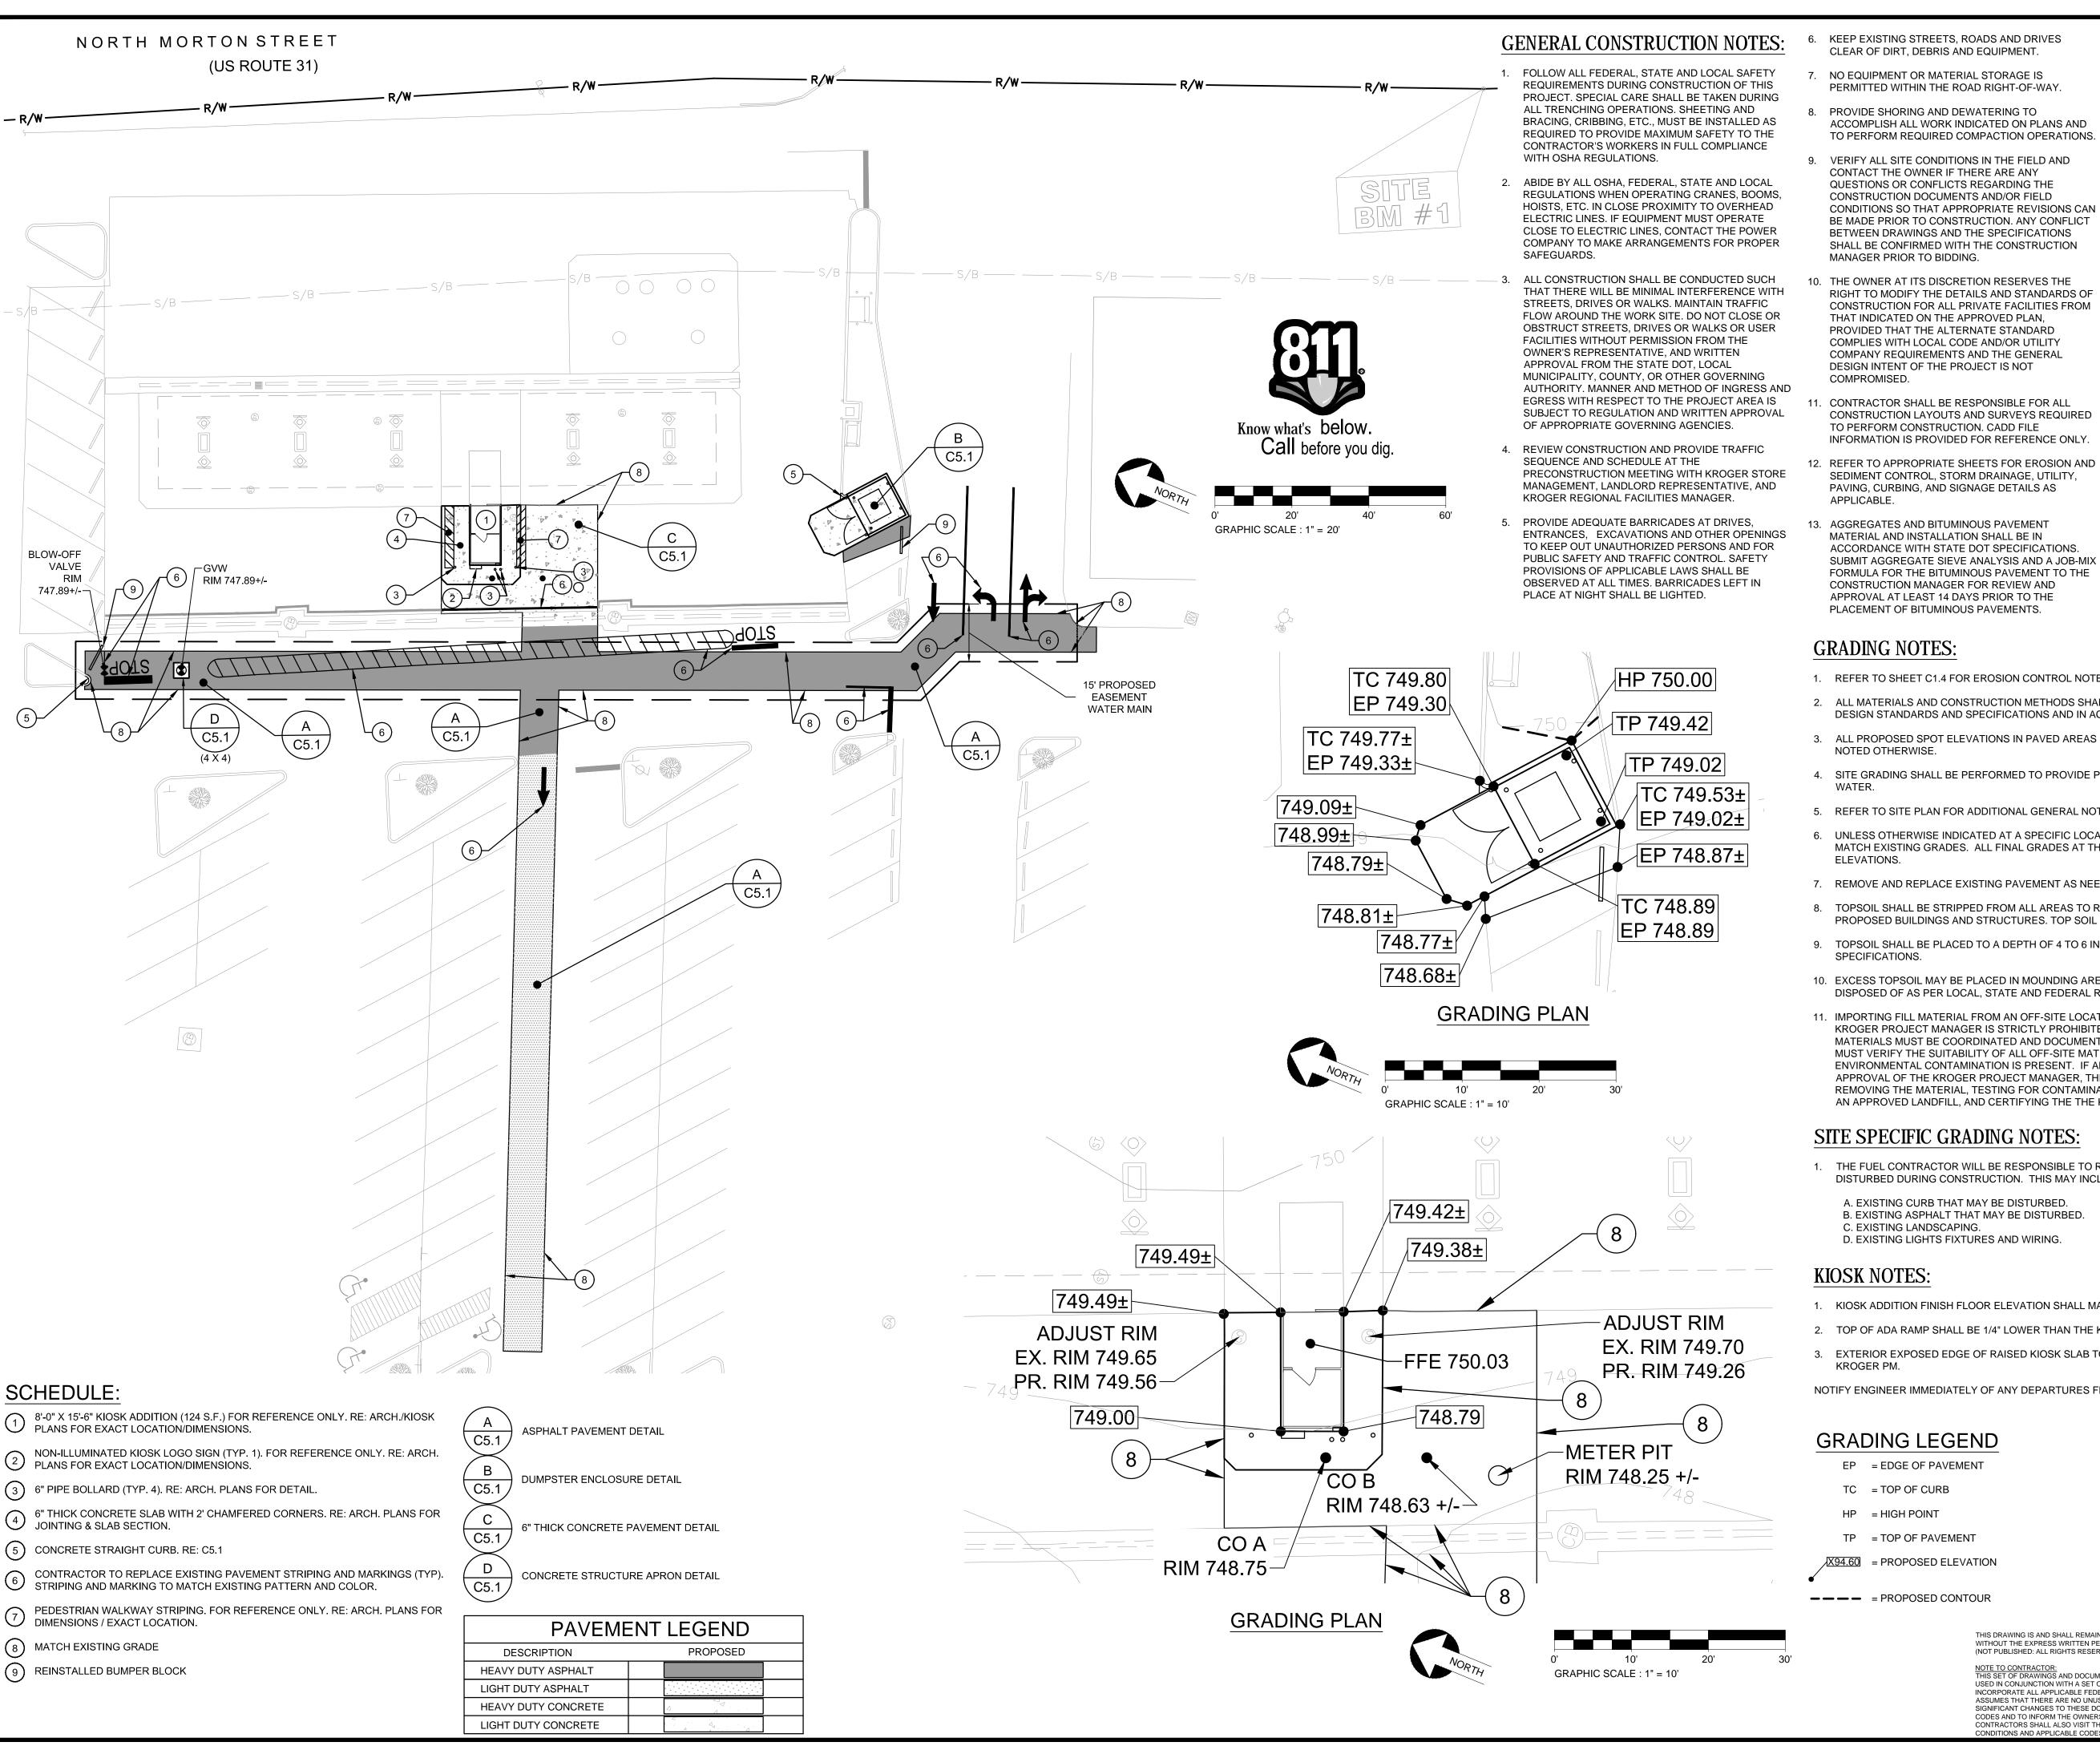
SEXTON

TEMEROWSKI

COVER SHEET

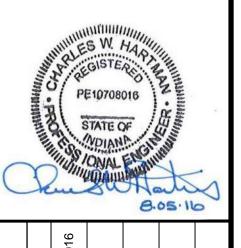Project Manager:



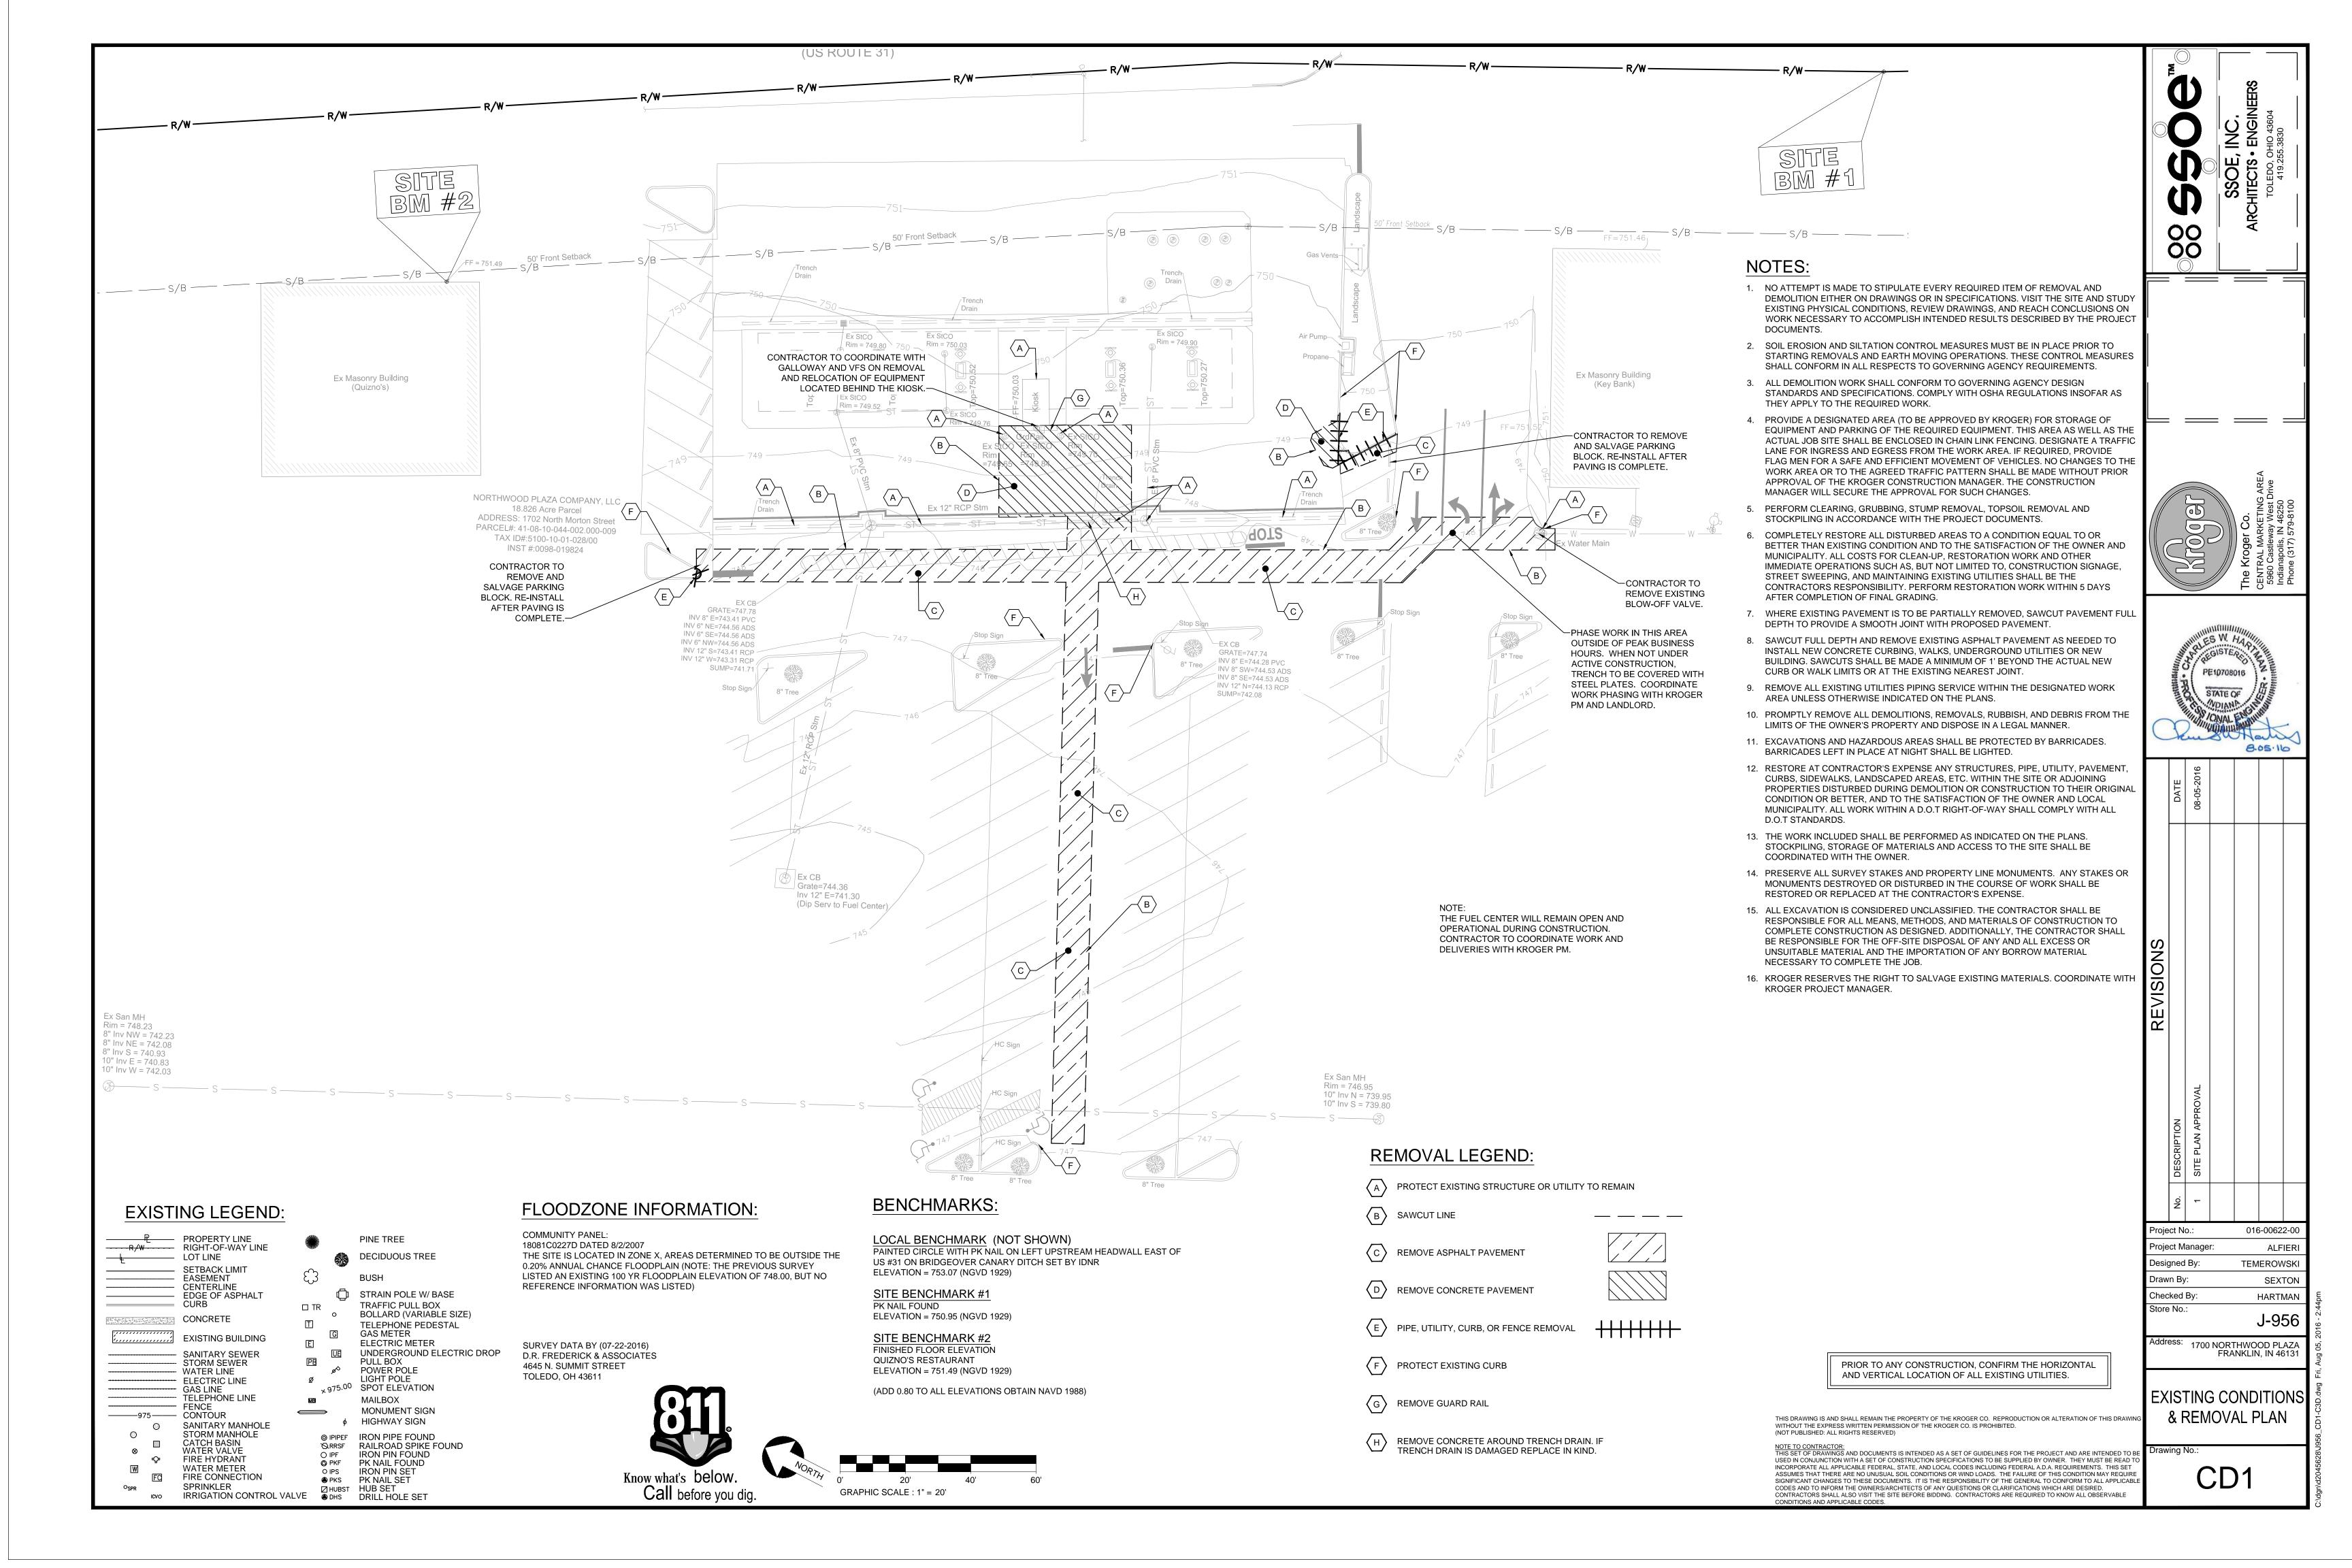

- 6. KEEP EXISTING STREETS, ROADS AND DRIVES CLEAR OF DIRT, DEBRIS AND EQUIPMENT.
 - NO EQUIPMENT OR MATERIAL STORAGE IS
- PROVIDE SHORING AND DEWATERING TO ACCOMPLISH ALL WORK INDICATED ON PLANS AND TO PERFORM REQUIRED COMPACTION OPERATIONS.
- 9. VERIFY ALL SITE CONDITIONS IN THE FIELD AND CONTACT THE OWNER IF THERE ARE ANY QUESTIONS OR CONFLICTS REGARDING THE CONSTRUCTION DOCUMENTS AND/OR FIELD CONDITIONS SO THAT APPROPRIATE REVISIONS CAN BE MADE PRIOR TO CONSTRUCTION, ANY CONFLICT BETWEEN DRAWINGS AND THE SPECIFICATIONS SHALL BE CONFIRMED WITH THE CONSTRUCTION MANAGER PRIOR TO BIDDING.
- 10. THE OWNER AT ITS DISCRETION RESERVES THE RIGHT TO MODIFY THE DETAILS AND STANDARDS OF CONSTRUCTION FOR ALL PRIVATE FACILITIES FROM THAT INDICATED ON THE APPROVED PLAN, PROVIDED THAT THE ALTERNATE STANDARD COMPLIES WITH LOCAL CODE AND/OR UTILITY COMPANY REQUIREMENTS AND THE GENERAL DESIGN INTENT OF THE PROJECT IS NOT COMPROMISED.
- 11. CONTRACTOR SHALL BE RESPONSIBLE FOR ALL CONSTRUCTION LAYOUTS AND SURVEYS REQUIRED TO PERFORM CONSTRUCTION. CADD FILE INFORMATION IS PROVIDED FOR REFERENCE ONLY.
- SEDIMENT CONTROL, STORM DRAINAGE, UTILITY, PAVING, CURBING, AND SIGNAGE DETAILS AS APPLICABLE. 13. AGGREGATES AND BITUMINOUS PAVEMENT
- MATERIAL AND INSTALLATION SHALL BE IN ACCORDANCE WITH STATE DOT SPECIFICATIONS. SUBMIT AGGREGATE SIEVE ANALYSIS AND A JOB-MIX FORMULA FOR THE BITUMINOUS PAVEMENT TO THE CONSTRUCTION MANAGER FOR REVIEW AND APPROVAL AT LEAST 14 DAYS PRIOR TO THE PLACEMENT OF BITUMINOUS PAVEMENTS.

- 14. VERIFY ALL DIMENSIONS FOR BUILDING, WALLS, CONCRETE SLABS, UTILITY SERVICE POINT CONNECTIONS, AND THE PROPOSED WORK, AND NOTIFYING THE OWNER AND ENGINEER OF ANY CONFLICTS OR DISCREPANCIES PRIOR TO CONSTRUCTION.
- 15. SUBMIT SHOP DRAWINGS OF ALL PRODUCTS AND MATERIALS TO THE OWNER AND LOCAL UTILITY COMPANIES AS REQUIRED FOR REVIEW AND APPROVAL PRIOR TO FABRICATION OR DELIVERY TO THE SITE. ALLOW A MINIMUM OF 14 DAYS FOR
- REVIEW. 16. REFERENCE ARCHITECTURAL PLANS FOR EXACT DIMENSIONS AND CONSTRUCTION DETAILS OF BUILDING, CANOPY, ROOF DRAINS, RAISED

CONCRETE SIDEWALKS, AND RAMPS.

- 17. TRAFFIC CONTROL SIGNAGE SHALL CONFORM TO THE STATE DOT STANDARD DETAIL SHEETS AND THE MANUAL OF UNIFORM TRAFFIC CONTROL DEVICES. SIGNS SHALL BE INSTALLED PLUMB.
- 18. FIRE LANES SHALL BE ESTABLISHED AND PROPERLY DESIGNATED IN ACCORDANCE WITH THE LOCAL MUNICIPALITY AND LOCAL FIRE DEPARTMENT REQUIREMENTS.
- 19. REMOVE CONFLICTING PAVEMENT MARKINGS IN A METHOD APPROVED BY THE STATE DOT.
- 20. ALTERNATIVE METHODS AND PRODUCTS OTHER THAN THOSE SPECIFIED MAY BE USED IF REVIEWED AND APPROVED BY THE OWNER, ENGINEER, AND APPROPRIATE REGULATORY AGENCIES PRIOR TO INSTALLATION.
- 21. PROVIDE AS-BUILT RECORDS OF ALL CONSTRUCTION (INCLUDING UNDERGROUND UTILITIES) TO THE ENGINEER FOLLOWING COMPLETION OF CONSTRUCTION ACTIVITIES.

PE10708016

GRADING NOTES:

- 1. REFER TO SHEET C1.4 FOR EROSION CONTROL NOTES.
- 2. ALL MATERIALS AND CONSTRUCTION METHODS SHALL BE IN CONFORMANCE WITH THE LOCAL MUNICIPALITY DESIGN STANDARDS AND SPECIFICATIONS AND IN ACCORDANCE WITH THESE PLANS.
- 3. ALL PROPOSED SPOT ELEVATIONS IN PAVED AREAS SHALL BE CONSIDERED TOP OF PAVEMENT GRADES UNLESS NOTED OTHERWISE.
- 4. SITE GRADING SHALL BE PERFORMED TO PROVIDE POSITIVE DRAINAGE AT ALL TIMES TO ENSURE NO STANDING
- 5. REFER TO SITE PLAN FOR ADDITIONAL GENERAL NOTES AND UTILITY PLAN FOR UTILITY NOTES.
- 6. UNLESS OTHERWISE INDICATED AT A SPECIFIC LOCATION, ALL FINISHED GRADES ARE TO CONFORM TO AND MATCH EXISTING GRADES. ALL FINAL GRADES AT THE PROJECT BOUNDARY SHALL MATCH EXISTING ELEVATIONS.
- 7. REMOVE AND REPLACE EXISTING PAVEMENT AS NEEDED TO MEET PROPOSED AND EXISTING GRADES
- 8. TOPSOIL SHALL BE STRIPPED FROM ALL AREAS TO RECEIVE PAVING AND FROM WITHIN THE LIMITS OF PROPOSED BUILDINGS AND STRUCTURES. TOP SOIL SHALL BE STRIPPED TO THE DEPTH OF 6 INCHES.
- 9. TOPSOIL SHALL BE PLACED TO A DEPTH OF 4 TO 6 INCHES IN ALL AREAS TO BE SEEDED OR SODDED PER THE SPECIFICATIONS.
- 10. EXCESS TOPSOIL MAY BE PLACED IN MOUNDING AREAS AND NONSTRUCTURAL FILL AREAS AS AVAILABLE OR DISPOSED OF AS PER LOCAL, STATE AND FEDERAL REGULATIONS.
- 11. IMPORTING FILL MATERIAL FROM AN OFF-SITE LOCATION WITHOUT PRIOR WRITTEN APPROVAL FROM THE KROGER PROJECT MANAGER IS STRICTLY PROHIBITED. IDENTIFICATION OF OFF-SITE BORROW LOCATIONS AND MUST VERIFY THE SUITABILITY OF ALL OFF-SITE MATERIAL. THIS INCLUDES AN ANALYSIS TO ENSURE THAT NO ENVIRONMENTAL CONTAMINATION IS PRESENT. IF ANY MATERIAL IS BROUGHT ON SITE WITHOUT WRITTEN APPROVAL OF THE KROGER PROJECT MANAGER, THE CONTRACTOR WILL BEAR ALL COST ASSOCIATED WITH REMOVING THE MATERIAL, TESTING FOR CONTAMINATION, MONITORING THE CLEAN-UP OPERATION, DISPOSAL I AN APPROVED LANDFILL, AND CERTIFYING THE THE KROGER SITE IS ENVIRONMENTALLY CLEAN.

SITE SPECIFIC GRADING NOTES:

- 1. THE FUEL CONTRACTOR WILL BE RESPONSIBLE TO REPAIR ANY EXISTING SITE IMPROVEMENTS THAT MAY BE DISTURBED DURING CONSTRUCTION. THIS MAY INCLUDE, BUT NOT BE LIMITED TO:
 - A. EXISTING CURB THAT MAY BE DISTURBED. B. EXISTING ASPHALT THAT MAY BE DISTURBED. C. EXISTING LANDSCAPING.

KIOSK NOTES:

- 1. KIOSK ADDITION FINISH FLOOR ELEVATION SHALL MATCH THE EXISTING KIOSK'S FINISH FLOOR ELEVATION.
- 2. TOP OF ADA RAMP SHALL BE 1/4" LOWER THAN THE KIOSK FINISH FLOOR ELEVATION.
- 3. EXTERIOR EXPOSED EDGE OF RAISED KIOSK SLAB TO BE SEALED OR PAINTED, COORDINATE TREATMENT WITH KROGER PM.

NOTIFY ENGINEER IMMEDIATELY OF ANY DEPARTURES FROM THESE DESIGN CONSTRAINTS.

GRADING LEGEND

- EP = EDGE OF PAVEMENT
- TC = TOP OF CURB
- HP = HIGH POINT

 $\overline{X94.60}$ = PROPOSED ELEVATION

--- = PROPOSED CONTOUR

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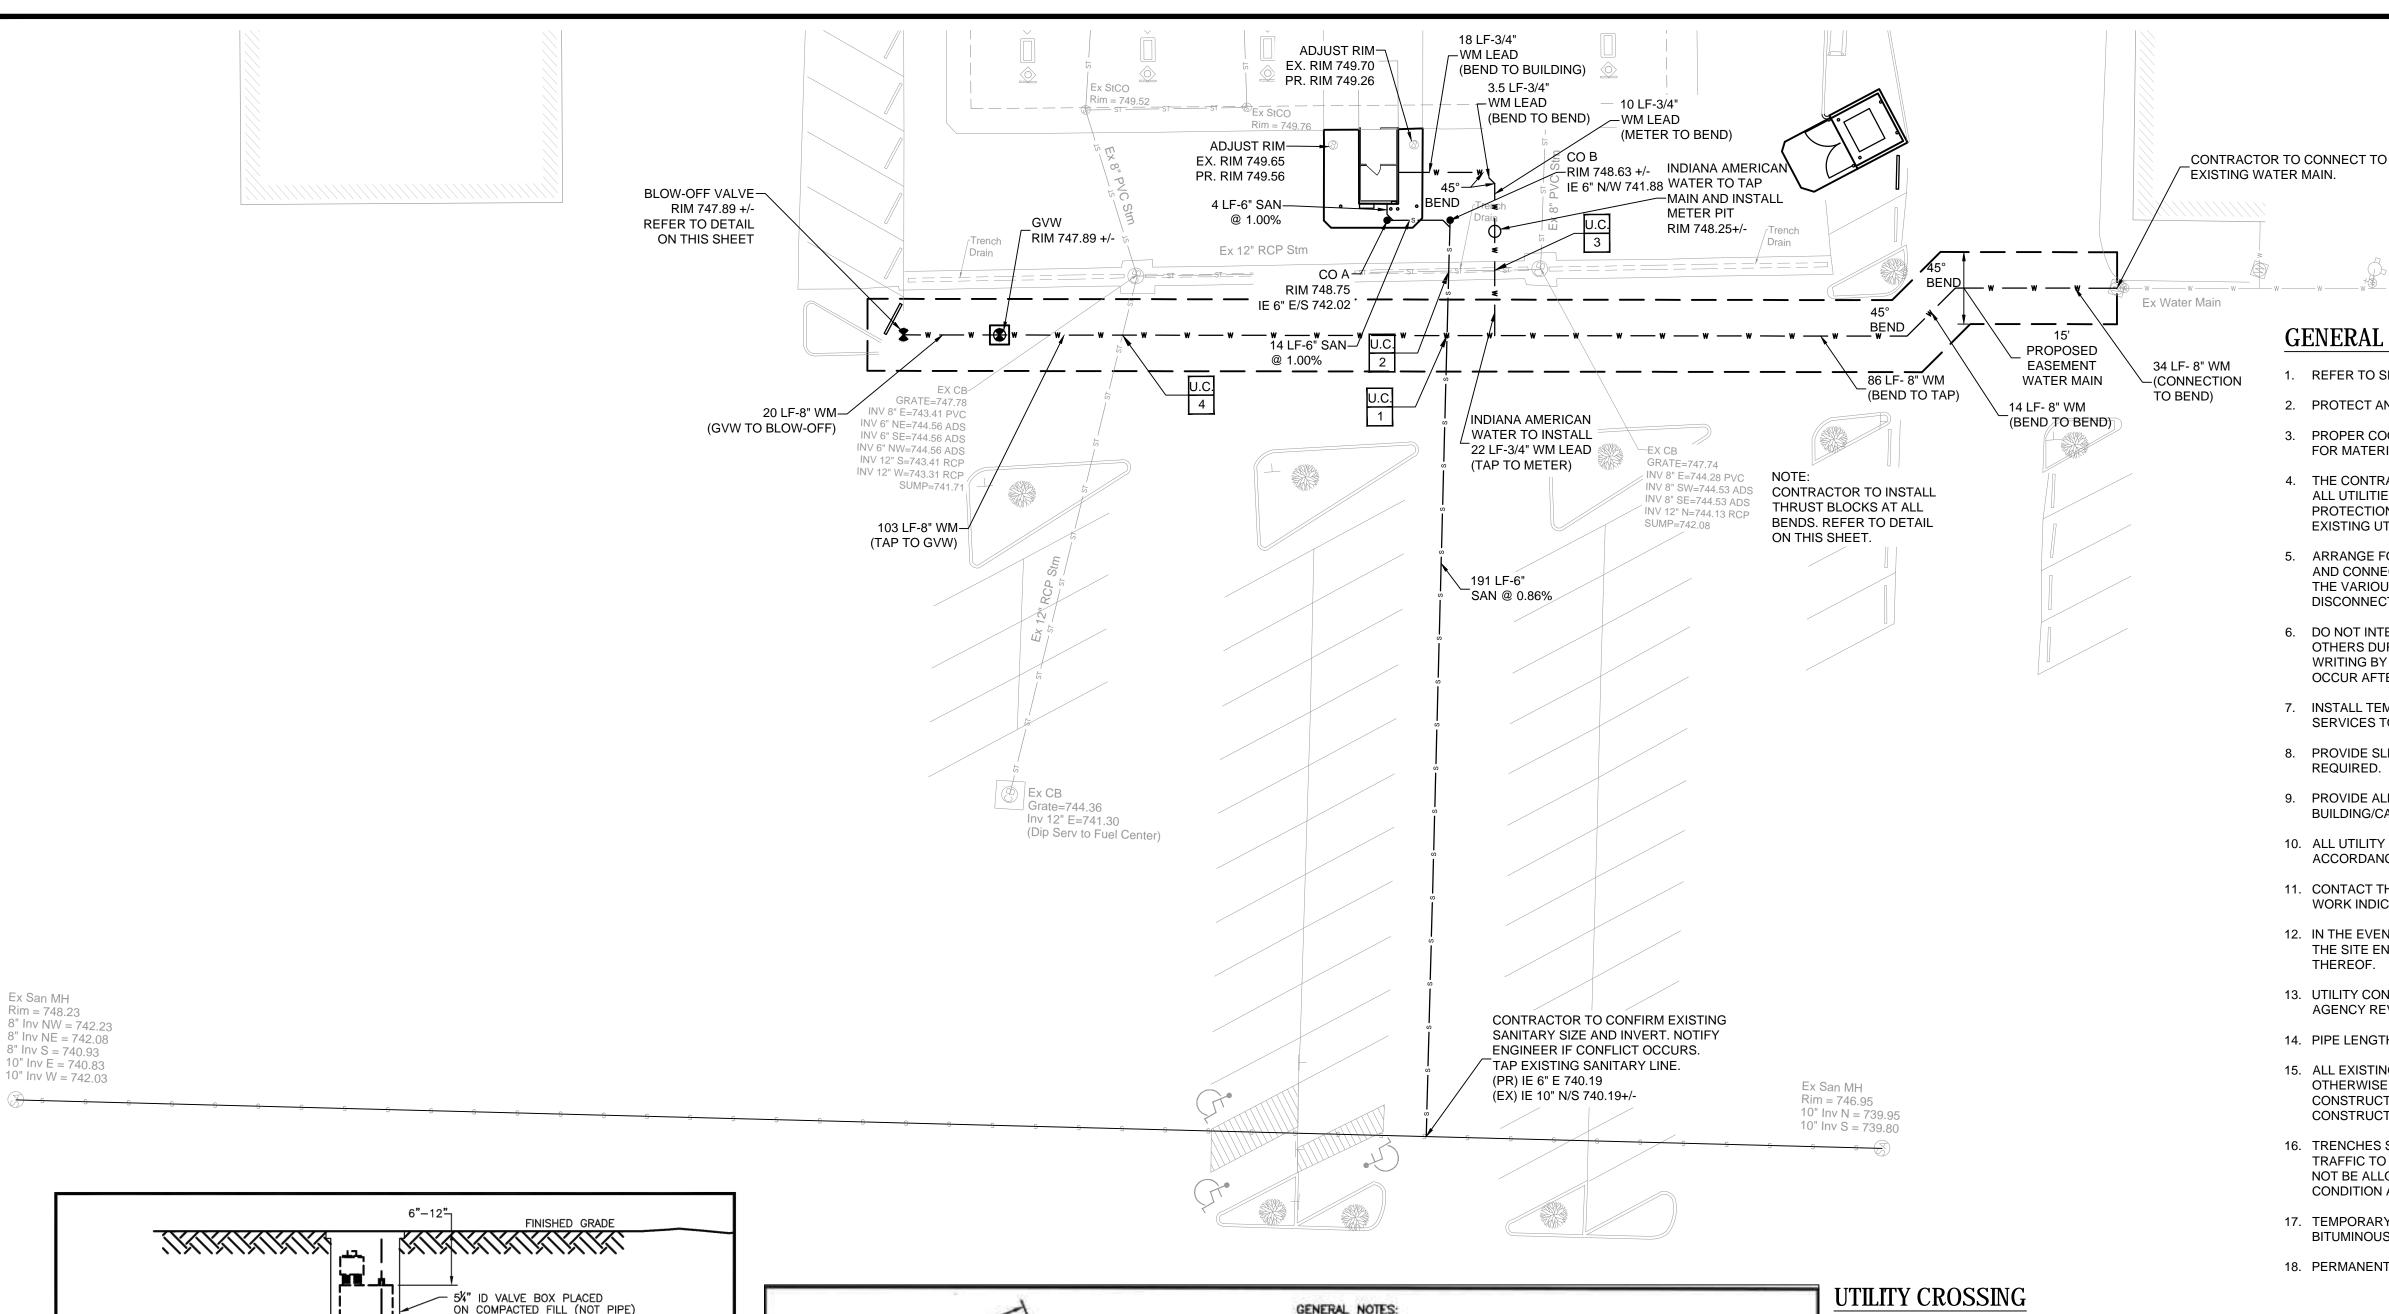
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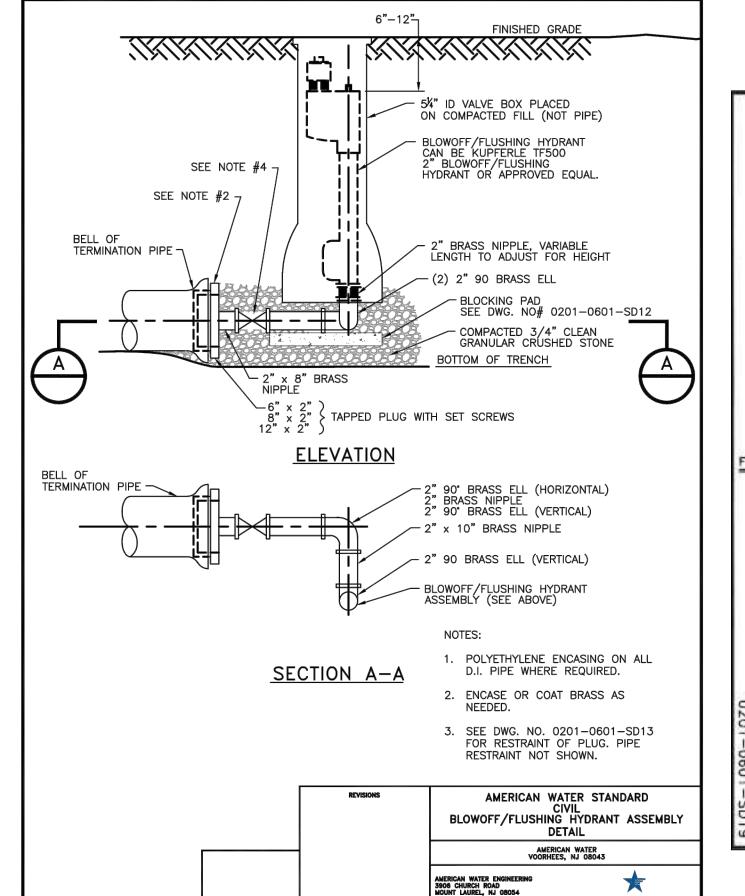
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oject No.: 016-00622-0 roject Manager ALFIERI esigned By: **TEMEROWSKI**

Drawn By: SEXTON Checked By:

HARTMAN J-956 ddress: 1700 NORTHWOOD PLAZA FRANKLIN, IN 46131 SITE PLAN






AMERICAN WATER

0201-0601-SD1

FOR COMMENTS

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U.C. BOTTOM OF 6" SANITARY LEAD 741.65 +/-TOP OF 8" WATER MAIN 740.15 +/-U.C. BOTTOM OF 12" STORM PIPE 743.80 +/-7 TOP OF 6" SANITARY SEWER 742.30 +/-U.C. BOTTOM OF 12" STORM PIPE 743.88 +/-3 TOP OF 3/4" WATER LEAD 742.38 +/-

U.C. BOTTOM OF 12" STORM PIPE 743.00 +/-4 TOP OF 8" WATER MAIN 741.50 +/-

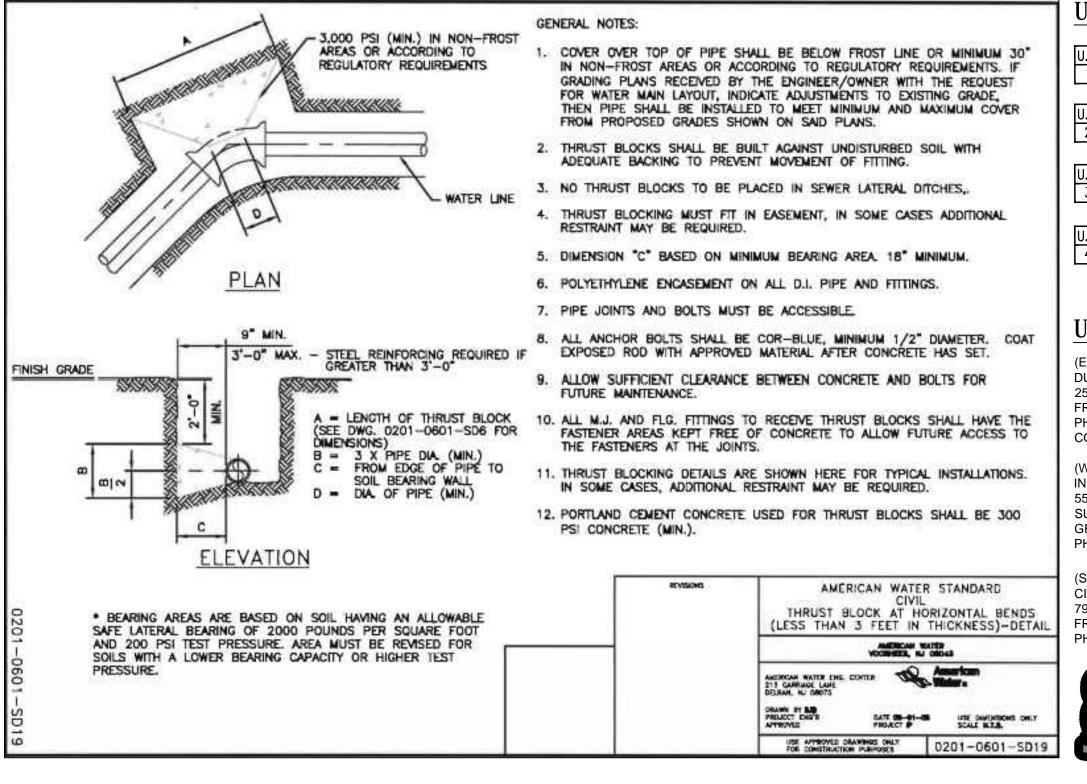UTILITY CONTACTS:

(ELECTRIC) **DUKE ENERGY** 2515 N. MORTON ST. FRANKLIN, IN 46131 PH: 317-7412-2204 CONTACT: TROY BURTON

SUITE 201 GREENWOOD, IN 46143 PH: 800- 492-8373

(SANITARY) CITY OF FRANKLIN (PUBLIC WORKS)



Call before you dig.



796 S STATE ST FRANKLIN, IN 46131 PH: 888-736-3640



GENERAL UTILITY NOTES

- 1. REFER TO SITE PLAN FOR ADDITIONAL GENERAL NOTES.
- 2. PROTECT AND MAINTAIN CROSSINGS OF OTHER UTILITY LINES.
- 3. PROPER COORDINATION SHALL BE PERFORMED TO ENSURE THAT ALL GOVERNING AGENCY STANDARDS FOR MATERIALS AND CONSTRUCTION METHODS ARE MET.
- 4. THE CONTRACTOR IS SOLELY RESPONSIBLE FOR DETERMINING ACTUAL LOCATIONS AND ELEVATIONS OF ALL UTILITIES, INCLUDING SERVICES PRIOR TO CONSTRUCTION. CONTACT THE STATE UTILITIES PROTECTION SERVICE @ 811 AT LEAST 48 HOURS BEFORE THE START OF THE WORK AND VERIFY ALL EXISTING UTILITY LOCATIONS.
- ARRANGE FOR AND COORDINATE WITH THE RESPECTIVE UTILITY COMPANIES FOR SERVICE INSTALLATIONS AND CONNECTIONS AND MAIN AND SERVICE RELOCATIONS. COORDINATE THE WORK TO BE PERFORMED BY THE VARIOUS GOVERNING AGENCIES AND SECURE ALL PERMITS AND PAY ALL FEES FOR CONNECTIONS, DISCONNECTIONS, RELOCATIONS, INSPECTIONS, AND DEMOLITION AS NECESSARY.

DO NOT INTERRUPT EXISTING UTILITIES SERVICING FACILITIES OCCUPIED AND USED BY THE OWNER OR

- OTHERS DURING OCCUPIED HOURS EXCEPT WHEN SUCH INTERRUPTIONS HAVE BEEN AUTHORIZED IN WRITING BY THE OWNER, LOCAL MUNICIPALITY AND/OR UTILITY COMPANY. INTERRUPTIONS SHALL ONLY OCCUR AFTER ACCEPTABLE TEMPORARY OR PERMANENT SERVICE HAS BEEN PROVIDED.
- INSTALL TEMPORARY SITE LIGHTING, GAS, SANITARY, WATER, STORM, ELECTRIC, TELEPHONE, AND CABLE SERVICES TO BUILDING(S) THAT REMAIN OPEN DURING CONSTRUCTION, AS NECESSARY.
- 8. PROVIDE SLEEVES UNDER FOOTINGS OR THROUGH FOUNDATIONS FOR UTILITY CONNECTIONS AS
- BUILDING/CANOPY STUB-OUTS. 10. ALL UTILITY CONSTRUCTION IS SUBJECT TO INSPECTION PRIOR TO APPROVAL FOR BACKFILL, IN

9. PROVIDE ALL BENDS, FITTINGS, ADAPTERS, ETC. AS REQUIRED FOR PIPE CONNECTIONS TO

- ACCORDANCE WITH THE APPROPRIATE GOVERNING AGENCY. 11. CONTACT THE LOCAL COUNTY HEALTH DEPARTMENT AND FILE AND OBTAIN A PLUMBING PERMIT FOR THE
- WORK INDICATED HEREIN AND COMPLY WITH THE LOCAL COUNTY PLUMBING CODE.
- 12. IN THE EVENT OF CONFLICT OF ANY REQUIREMENTS OR PROVISIONS OF THE WORK INDICATED HEREON, THE SITE ENGINEER SHALL BE NOTIFIED FOR A DETERMINATION OF THE PLAN REQUIREMENTS AND INTENT
- 13. UTILITY CONNECTION DESIGN AS REFLECTED ON THE PLAN MAY CHANGE SUBJECT TO GOVERNING AGENCY REVIEW.
- 14. PIPE LENGTHS SHOWN ARE MEASURED FROM CENTER OF STRUCTURE TO CENTER OF STRUCTURE.
- 15. ALL EXISTING MANHOLES/CATCH BASINS ARE ASSUMED TO BE FOUR (4) FEET IN DIAMETER UNLESS OTHERWISE NOTED ON PLANS. CONTRACTOR TO FIELD VERIFY MANHOLE/CATCH BASIN SIZE AND ENSURE CONSTRUCTABILITY OF THE CONNECTIONS AS SHOWN ON THE PLANS PRIOR TO BEGINNING CONSTRUCTION.
- 16. TRENCHES SHOULD BE BACKFILLED AND THE PAVEMENT RESTORED IN SUCH A MANNER THAT ALLOWS TRAFFIC TO SAFELY TRAVEL ALONG AND/OR CROSS IT DURING NON-CONSTRUCTION HOURS. HOLES SHALL NOT BE ALLOWED DURING NON-CONSTRUCTION HOURS. KEEP THE TRENCH AREA IN A SAFE PASSABLE CONDITION AT ALL TIMES.
- 17. TEMPORARY PAVEMENT RESTORATION SHOULD CONSIST OF AT LEAST 3 INCHES OF COMPACTED BITUMINOUS COLD PATCH.
- 18. PERMANENT PAVEMENT RESTORATION SHALL BE COMPLETED IN A TIMELY MANNER.

SANITARY SEWER NOTES

- 1. DOWNSPOUT, FOOTER DRAINS OR OTHER CLEAN WATER CONNECTIONS TO THE SANITARY SEWER SYSTEM ARE PROHIBITED.
- 2. TEST THE SANITARY SEWER FOR LEAKAGE IN ACCORDANCE WITH THE GOVERNING AGENCY'S REQUIREMENTS. THE INSPECTOR FOR THE MUNICIPALITY/UTILITY SHALL BE PRESENT DURING TESTING.

WATER NOTES

- 1. INSTALL WATER MAIN/LEAD WITH A MINIMUM OF FIVE (5) FEET OF COVER
- 2. PROVIDE A MINIMUM OF EIGHTEEN (18) INCHES OF VERTICAL SEPARATION AND TEN (10) FEET OF HORIZONTAL SEPARATION BETWEEN THE WATER MAIN AND ALL SANITARY AND STORM SEWERS.

MATERIAL NOTES

ALL MATERIAL SHALL COMPLY WITH THE LOCAL MUNICIPALITY DESIGN & PROJECT SPECIFICATIONS.

MAIN LINE SHALL BE ALL PVC PIPE 4" TO 12" INSTALLED SHALL BE DR 18 (235 PSI PRESSURE CLASS PER AWWA C900) WITH MECHANICAL JOINTS. MECHANICAL JOINTS ARE TO BE DUCTILE IRON FITTINGS CONNECTED TO PVC PIPE WITH MECHANICAL JOINT RESTRAINT DEVICES. CONCRETE THRUST BLOCKS SHALL BE INSTALLED AT ALL BENDS. REFER TO INDIANA AMERICAN WATER FOR SPECIFICATIONS AND REQUIREMENTS.

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NCORPORATE ALL APPLICABLE FEDERAL, STATE, AND LOCAL CODES INCLUDING FEDERAL A.D.A. REQUIREMENTS. THIS SET

ASSUMES THAT THERE ARE NO UNUSUAL SOIL CONDITIONS OR WIND LOADS. THE FAILURE OF THIS CONDITION MAY REQUIR IGNIFICANT CHANGES TO THESE DOCUMENTS. IT IS THE RESPONSIBILITY OF THE GENERAL TO CONFORM TO ALL APPLICABL

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SERVICE LINE (WATER LEAD) SHALL BE HDPE SDR-11 (200 PSI) MINIMUM. REFER TO INDIANA AMERICAN WATER FOR SPECIFICATIONS AND REQUIREMENTS.

SANITARY SEWER: PVC PIPE ASTM D3034 (SDR-35) PIPE JOINT ASTM D3212

> hecked By: HARTMAN J-956 ddress: 1700 NORTHWOOD PLAZA FRANKLIN, IN 46131

oject No.:

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oject Manager


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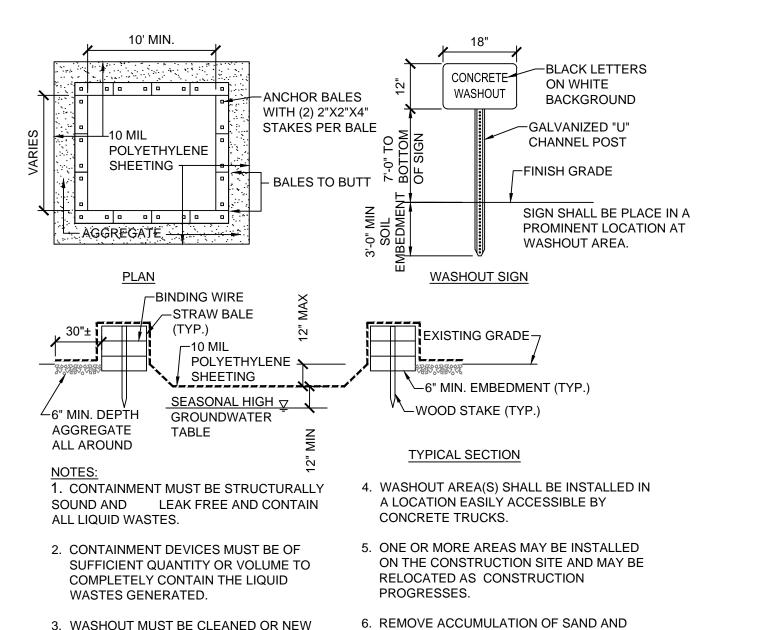
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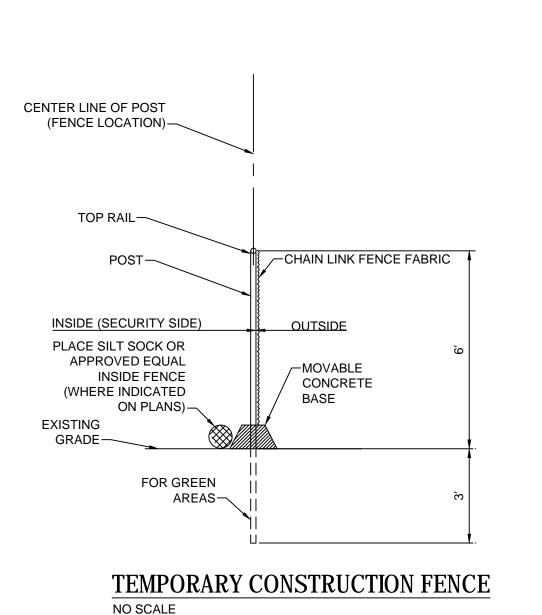
UTILITY PLAN






AGGREGATE AND DISPOSE OF PROPERLY FACILITIES CONSTRUCTED AND READY TO AT LEAST WEEKLY. USE ONCE WASHOUT IS 75% FULL. **CONCRETE WASHOUT AREA** NO SCALE

3. WASHOUT MUST BE CLEANED OR NEW

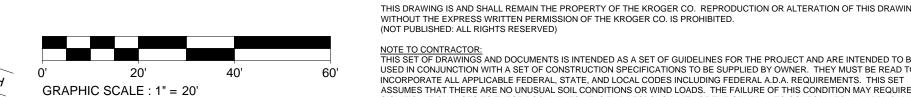

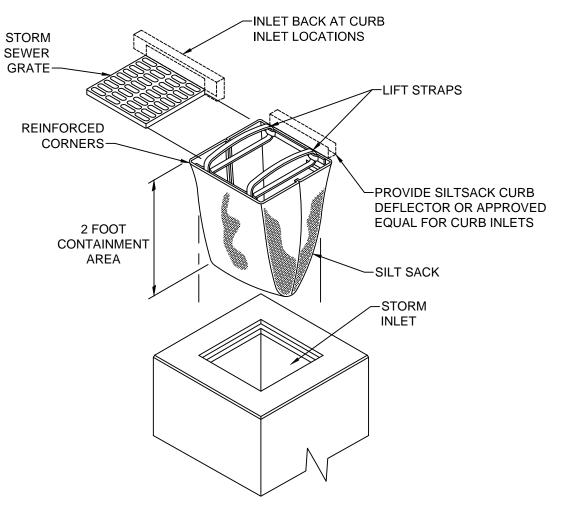

TEMPORARY INLET SEDIMENT FILTER TO BE USED FOR STORM INLETS AND CATCH BASINS LOCATED IN PAVED

EROSION CONTROL NOTES:

- 1. BECOME COMPLETELY FAMILIAR WITH THE GEOTECHNICAL REPORT PRIOR TO BEGINNING ANY WORK.
- 2. MAINTAIN THE SWPPP AS SPECIFIED IN SECTION 31 25 00 OF THE PROJECT MANUAL.
- 3. CONSTRUCT AND MAINTAIN ALL SOIL EROSION CONTROL MEASURES IN ACCORDANCE WITH STATE AND LOCAL REQUIREMENTS AND PROJECT DOCUMENTS.
- 4. CONSTRUCTION OPERATIONS SHALL BE SCHEDULED AND PERFORMED SO THAT PREVENTATIVE EROSION CONTROL MEASURES ARE IN PLACE PRIOR TO EXCAVATION AND TEMPORARY STABILIZATION MEASURES ARE IN PLACE IMMEDIATELY FOLLOWING BACKFILLING AND/OR GRADING OPERATIONS.
- 5. ANY EROSION AND SEDIMENT FROM WORK ON THIS SITE SHALL BE CONTAINED ON THE SITE AND NOT ALLOWED TO COLLECT IN ANY OFF-SITE AREAS OR IN WATERWAYS. WATERWAYS INCLUDE NATURAL AND MANMADE OPEN DITCHES, STREAMS, STORM DRAINS, LAKE AND PONDS.
- 6. KEEP NEIGHBORING STREETS CLEAN AND FREE OF MUD AND DEBRIS.
- 7. DIRECT ALL DEWATERING ACTIVITIES TO THE EXISTING STORM SYSTEM. PASS ALL WATER THROUGH A FILTER PRIOR TO
- 8. CONSTRUCT AND MAINTAIN INLET FILTER AT ALL CATCH BASINS AND INLET STRUCTURES THAT HAVE THE POTENTIAL TO RECEIVE SEDIMENT LADEN RUNOFF UNTIL PERMANENT MEASURES ARE IN PLACE.
- 9. ENSURE SOIL AND DEBRIS FROM THE SITE REMAINS ON SITE THROUGH THE USE OF CLEAN STONE EXITS. DIRECT ALL CONSTRUCTION TRAFFIC TO THESE EXITS.
- 10. PROVIDE, MAINTAIN, AND REMOVE A CONCRETE WASHOUT AREA WITH GUIDANCE FROM THE READY MIX WASHOUT GUIDEBOOK AND IN ACCORDANCE WITH LOCAL, STATE AND FEDERAL REQUIREMENTS. ALL MATERIAL CONTAINED WITHIN THE WASHOUT AREA SHALL BE DISPOSED OF PROPERLY.
- 11. CONTROL DUST AT ALL TIMES DURING CONSTRUCTION.
- 12. SPECIAL PRECAUTIONS SHALL BE TAKEN IN THE USE OF CONSTRUCTION EQUIPMENT TO PREVENT SITUATIONS THAT
- 13. THE PROJECT SHALL CONTINUALLY BE INSPECTED FOR SOIL EROSION AND SEDIMENT CONTROL COMPLIANCE. DEFICIENCIES WILL BE CORRECTED WITHIN 24 HOURS.
- 14. CLEANUP SHALL BE DONE IN A MANNER TO ENSURE THAT EROSION CONTROL MEASURES ARE NOT DISTURBED.
- 15. FINAL SITE SOIL EROSION CONTROL STABILIZATION, SUCH AS SEED OR SOD, IS TO BE COMPLETED WITHIN FIVE (5) DAYS OF FINAL GRADING.
- 16. TEMPORARY EROSION CONTROL MEASURES SHALL BE COMPLETELY REMOVED BY THE CONTRACTOR UPON ESTABLISHMENT OF PERMANENT CONTROL MEASURES.

CONSTRUCTION SEQUENCE:

- 1. PROVIDE TEMPORARY BEST MANAGEMENT PRACTICES (BMPs) PRIOR TO ANY EARTH MOVING ACTIVITIES.
- 2. COMPLETE PAVEMENT AND ITEM REMOVAL.
- 3. ROUGH GRADE SITE AND CONSTRUCT STORM SYSTEM. INSTALL AND MAINTAIN INLET FILTERS ON STORM STRUCTURES.
- 4. COMPLETE NEW CONSTRUCTION AS INDICATED ON THE PLANS.
- 5. INSPECT AND PERFORM MAINTENANCE OF BMPs DURING THE ENTIRE CONSTRUCTION EFFORT.
- 6. REMOVE TEMPORARY BMPs AFTER SITE IS STABILIZED AND AS DIRECTED BY THE OWNER AND/OR INSPECTOR.

SWPPP MAINTENANCE SCHEDULE NOTES:


INSPECT THE SOIL EROSION AND SEDIMENT CONTROL DEVICES ONCE EACH WEEK AND WITHIN TWENTY-FOUR (24) HOURS OF A PRECIPITATION EVENT WHICH RESULTS IN A STORM WATER DISCHARGE FROM THE SITE. A LOG OF INSPECTION REPORTS SHALL BE MAINTAINED AND ACCESSIBLE IN ACCORDANCE WITH NPDES REQUIREMENTS. IMPLEMENT THE FOLLOWING STEPS IF ANY DAMAGE HAS RESULTED FROM CONSTRUCTION OR WEAR.

- 1. INSPECT INLET FILTERS FOR BUILD-UP OF SILT AND OTHER DEBRIS. EXCESSIVE BUILD-UP IS EVIDENT IF GEOTEXTILE IS CAUSING FLOODING. MAINTENANCE CONSISTS OF REMOVING ALL SEDIMENT WITH A STIFF BRISTLE BROOM OR SQUARE POINT SHOVEL. IF INLET FILTER IS BEYOND THIS LEVEL OF REPAIR, IT MAY BE NECESSARY TO REPLACE THE GEOTEXTILE
- 2. MAINTAIN DUST CONTROL AT ALL TIMES DURING CONSTRUCTION. SPRINKLING TANK TRUCKS SHALL BE AVAILABLE AT ALL TIMES AND USED ON HAUL ROADS, ON-SITE DISTURBED AREAS, OR OTHER PLACES WHERE DUST BECOMES A PROBLEM AS A RESULT OF CONSTRUCTION EFFORTS.
- 3. PROMPTLY REMOVE ALL MUD, DIRT AND DEBRIS TRACKED ONTO EXISTING ROADS FROM THIS SITE.


EROSION CONTROL LEGEND

Know what's below.

Call before you dig.

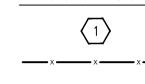

INLET FILTER CONSTRUCTION FENCE

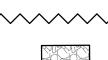

10' X 10' CONCRETE WASHOUT

SILT SOCK RE: TEMPORARY CONSTRUCTION FENCE DETAIL


SOIL EROSION / SEDIMENTATION CONTROL MAINTENANCE SCHEDULE												
CONSTRUCTION SEQUENCE	JAN	FEB	MAR	APR	MAY	JUN	JUL	AUG	SEP	ОСТ	NOV	DEC
INSTALL TEMPORARY BMPs										X		
TEMPORARY ENTRANCE										X		
SITE DEMO/SITE CONSTRUCTION										X	X	X
INLET FILTERS ON STRUCTURES											X	X
LANDSCAPING											X	X
FINAL GRADING											Χ	X
REMOVE TEMPORARY MEASURES											X	

ANTICIPATED CONSTRUCTION START DATE: OCTOBER 1, 2016 X = INSPECT WEEKLY OR AFTER EACH RAIN EVENT ANTICIPATED CONSTRUCTION END DATE: DECEMBER 13, 2016

GRAPHIC SCALE: 1" = 20' THIS DRAWING IS AND SHALL REMAIN THE PROPERTY OF THE KROGER CO. REPRODUCTION OR ALTERATION OF THIS DRAWIN WITHOUT THE EXPRESS WRITTEN PERMISSION OF THE KROGER CO. IS PROHIBITED. (NOT PUBLISHED: ALL RIGHTS RESERVED)

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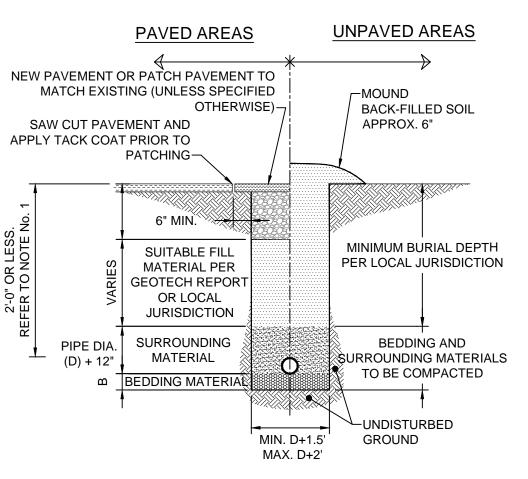


		80				
REVISIONS REVISIONS	Ro. DESCRIPTION	SITE PLAN APPROVAL		016	6-0062	2-00
Proje	ct M	anage	r:		ALF	IER

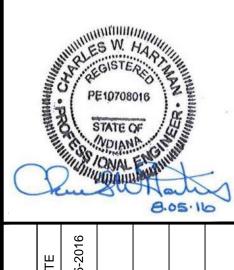Designed By: **TEMEROWSKI** Drawn By: SEXTON Checked By: HARTMAN

J-956 Address: 1700 NORTHWOOD PLAZA FRANKLIN, IN 46131

SWPPP



RECOMMENDED FILL MATERIALS

TYPE OF PIPE	SURROUNDING MATERIAL TYPE	B-DIMENSION	BEDDING MATERIAL TYPE
DUCTILE IRON PIPE	"A", "B", OR "C"	3"	SAND OR "C"
RCP PIPE	"B" OR "C"	3"	SAND OR "C"
ALL PIPE OVER BEDROCK OR LED	GE "B" OR "C"	6"	SAND OR "C"
RCP PIPE IN CLAY	"B" OR "C"	6"	SAND
PLASTIC-ALL	"C"	6"	SAND OR "C"

"RECOMMENDED FILL MATERIALS" ARE MINIMUM REQUIREMENTS.
CONTRACTOR SHALL ENSURE COMPLIANCE WITH LOCAL JURISDICTION AND/OR
THE RECOMMENDATIONS OF THE GEOTECHNICAL ENGINEER.


MATERIAL TYPES:


- "A": GRAVEL OR EXCAVATED MATERIAL WHICH HAS NO STONES GREATER THAN 1.5" DIAMETER.
- "B": STONE WITH 100% PASSING 1.5" SQUARE SIEVE, A MAXIMUM OF 25% PASSING A 3/4" SQUARE SIEVE AND A MAXIMUM 5% PASSING A 1/2" SQUARE SIEVE, PEA GRAVEL, BANK RUN, OR RUN OF BANK.
- "C": CRUSHED STONE WITH 100% PASSING A 1" SQUARE SIEVE AND 0-5% PASSING A 1/4" SQUARE SIEVE, PEA GRAVEL, OR OTHER NATURAL FREE DRAINING STONE MATERIAL WITH LESS THAN 10% P200 (PASSING NO. 200 SIEVE).

NOTE


- 1. THE SURROUNDING MATERIAL MUST BE INSTALLED TO THE PAVEMENT BASE ELEVATION IF THERE IS LESS THAN 2'-0" OF FILL OVER THE PIPE.
- 2. COMPACT ALL BACK FILL UNDERNEATH, AROUND AND ABOVE PROPOSE PIPES TO 95% STANDARD PROCTOR IN PAVED AND STRUCTURAL AREAS, 90% STANDARD PROCTOR IN UNPAVED OR NON-STRUCTURAL AREAS. THE UPPER 12" OF TRENCH BACKFILL MATERIAL IN PAVED/STRUCTURAL AREAS MUST BE COMPACTED TO 98% STANDARD PROCTOR (ASTM-698).
- 3. WHERE A PIPE HAS A SLOPE GREATER THAN OR EQUAL TO 4% OR WHERE GROUNDWATER IS PRESENT, CLAY DAMS SHALL BE INSTALLED AROUND THE PIPE EVERY 100' TO PREVENT WASHOUT AROUND THE PIPE.
- 4. ALL SUITABLE FILL SHOULD NOT CONTAIN STONES GREATER THAN 4" IN DIAMETER, FROZEN LUMPS, AND SHALL CONTAIN A MINIMAL AMOUNT OF ORGANIC MATERIALS (LESS THAN 3%).
- 5. MATERIAL IS TO BE PLACED AT NO MORE THAN 8" INTERVALS AND COMPACTED BEFORE PLACING NEXT LAYER.

TRENCH DETAIL

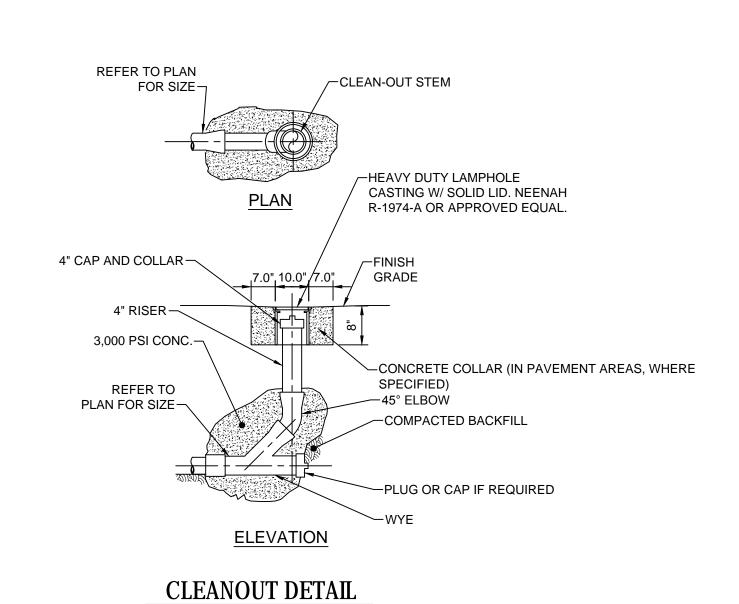

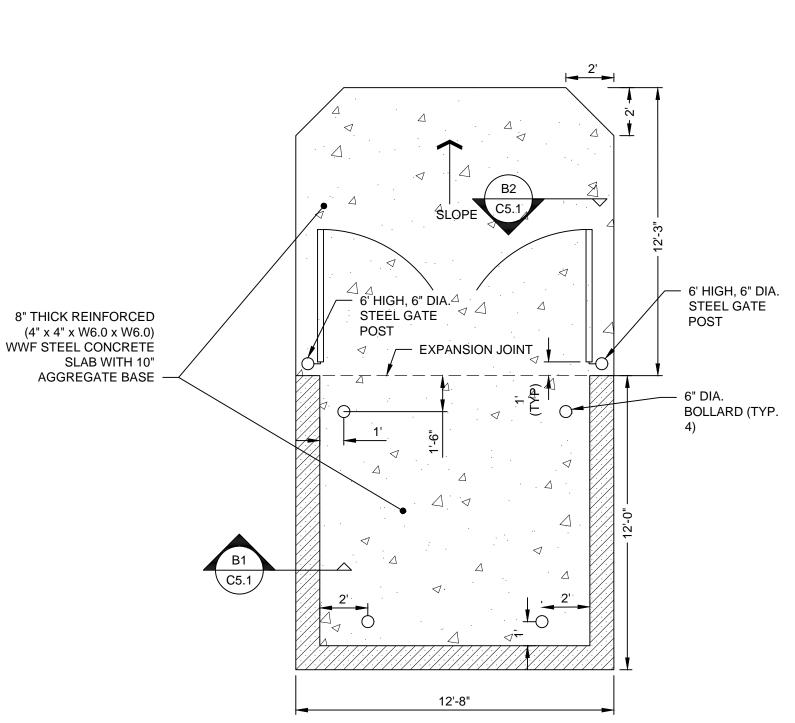



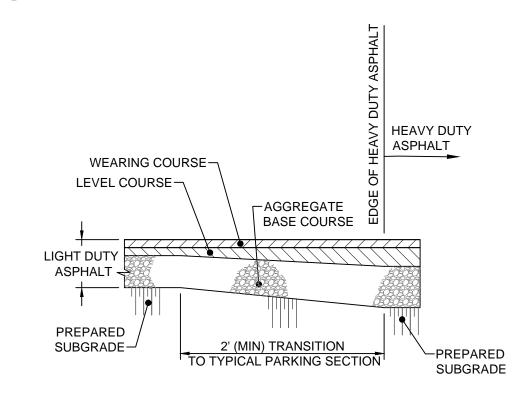

←EXISTING EDGE

-WEARING COURSE

-LEVEL COURSE

AGGREGATE

BASE COURSE

TYPICAL PAVEMENT TRANSITION

SCALE: NTS


EXISTING ASPHALT-

TYPICAL BUTT JOINT


SCALE: NTS

TO EXISTING PAVEMENT


SAWCUT-

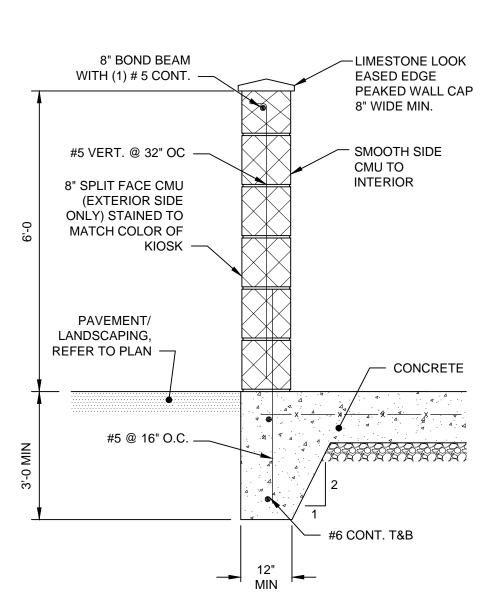



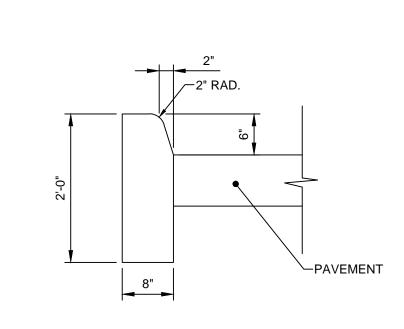


CONCRETE STRAIGHT CURB DETAIL (MATCH EXISTING)

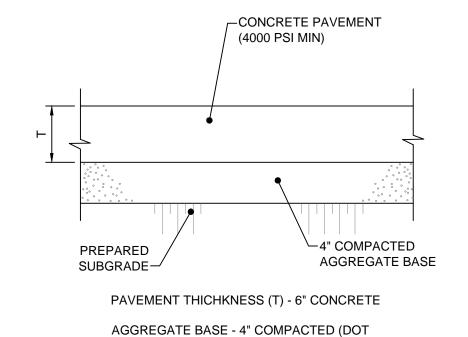


C 6" THICK CONCRETE PAVEMENT DETAIL
SCALE: NTS

CITATION)

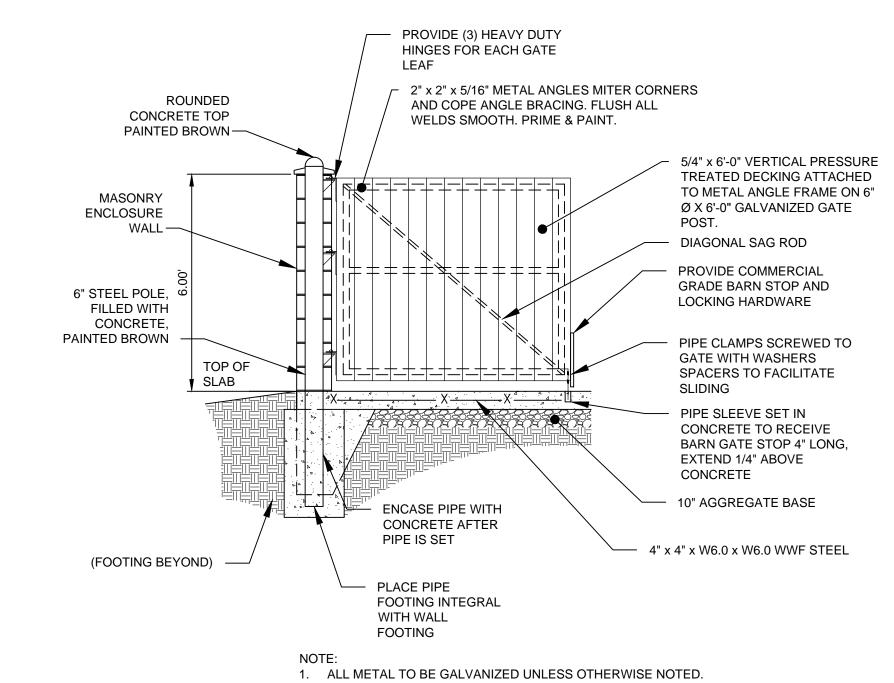

DUMPSTER ENCLOSURE GATE DETAIL

C5.1 SCALE: NTS

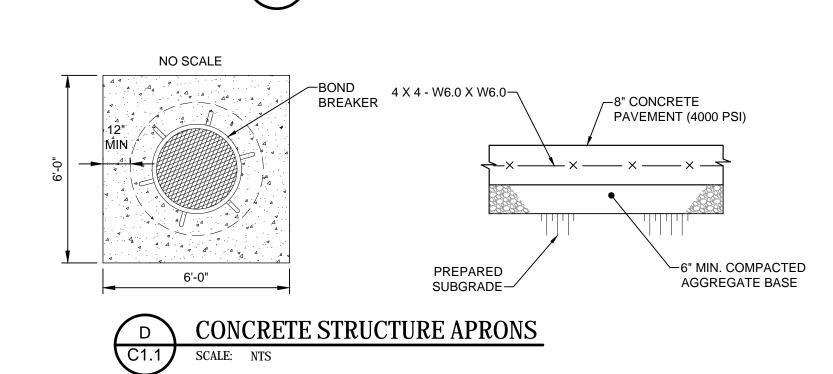

TENSAR TX5 REINFORCEMENT

-WEARING COURSE

-LEVEL COURSE

-BOND COAT

-AGGREGATE

BASE COURSE

-PREPARED SUBGRADE

TYPICAL HEAVY DUTY ASPHALT PAVEMENT SECTION

WEARING COURSE - 1.5" BITUMINOUS

LEVEL COURSE - 3.5" BITUMINOUS

AGGREGATE BASE - 9" COMPACTED

TYPICAL LIGHT DUTY ASPHALT PAVEMENT SECTION

WEARING COURSE - 1.5" BITUMINOUS

LEVEL COURSE - 2" BITUMINOUS

AGGREGATE BASE - 6" COMPACTED

NOTES:

1. GRAVEL BASE MATERIALS AND INSTALLATION PROCEDURES SHALL CONFORM TO INDOT SPECIFICATIONS.


2. ALL PAVING MATERIALS AND INSTALLATION PROCEDURES SHALL CONFORM TO INDOT SPECIFICATIONS.





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SSOE, INC.
ARCHITECTS • ENGINEER





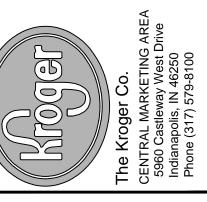

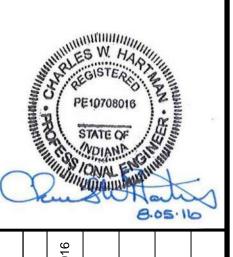Project Manager: ALFIERI
Designed By: TEMEROWSKI
Drawn By: SEXTON
Checked By: HARTMAN
Store No.:

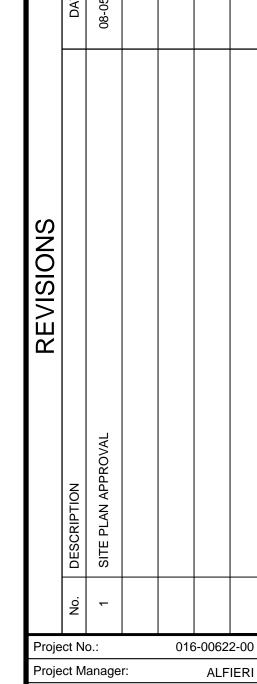J-956

SITE SPECIFIC DETAILS

Address: 1700 NORTHWOOD PLAZA FRANKLIN, IN 46131

C5.1